


RESIDENTIAL PLANNED DEVELOPMENT SUBMITTAL EDWARDS COMMUNITIES DEVELOPMENT COMPANY


BAYOU ST. JOHN - NEW ORLEANS - LOUISIANA

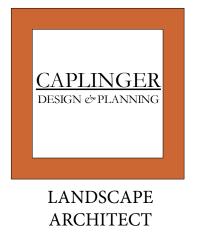







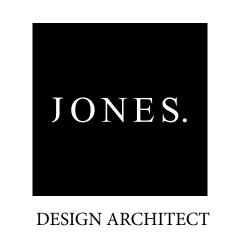







O' | Scale: 1" = 100'



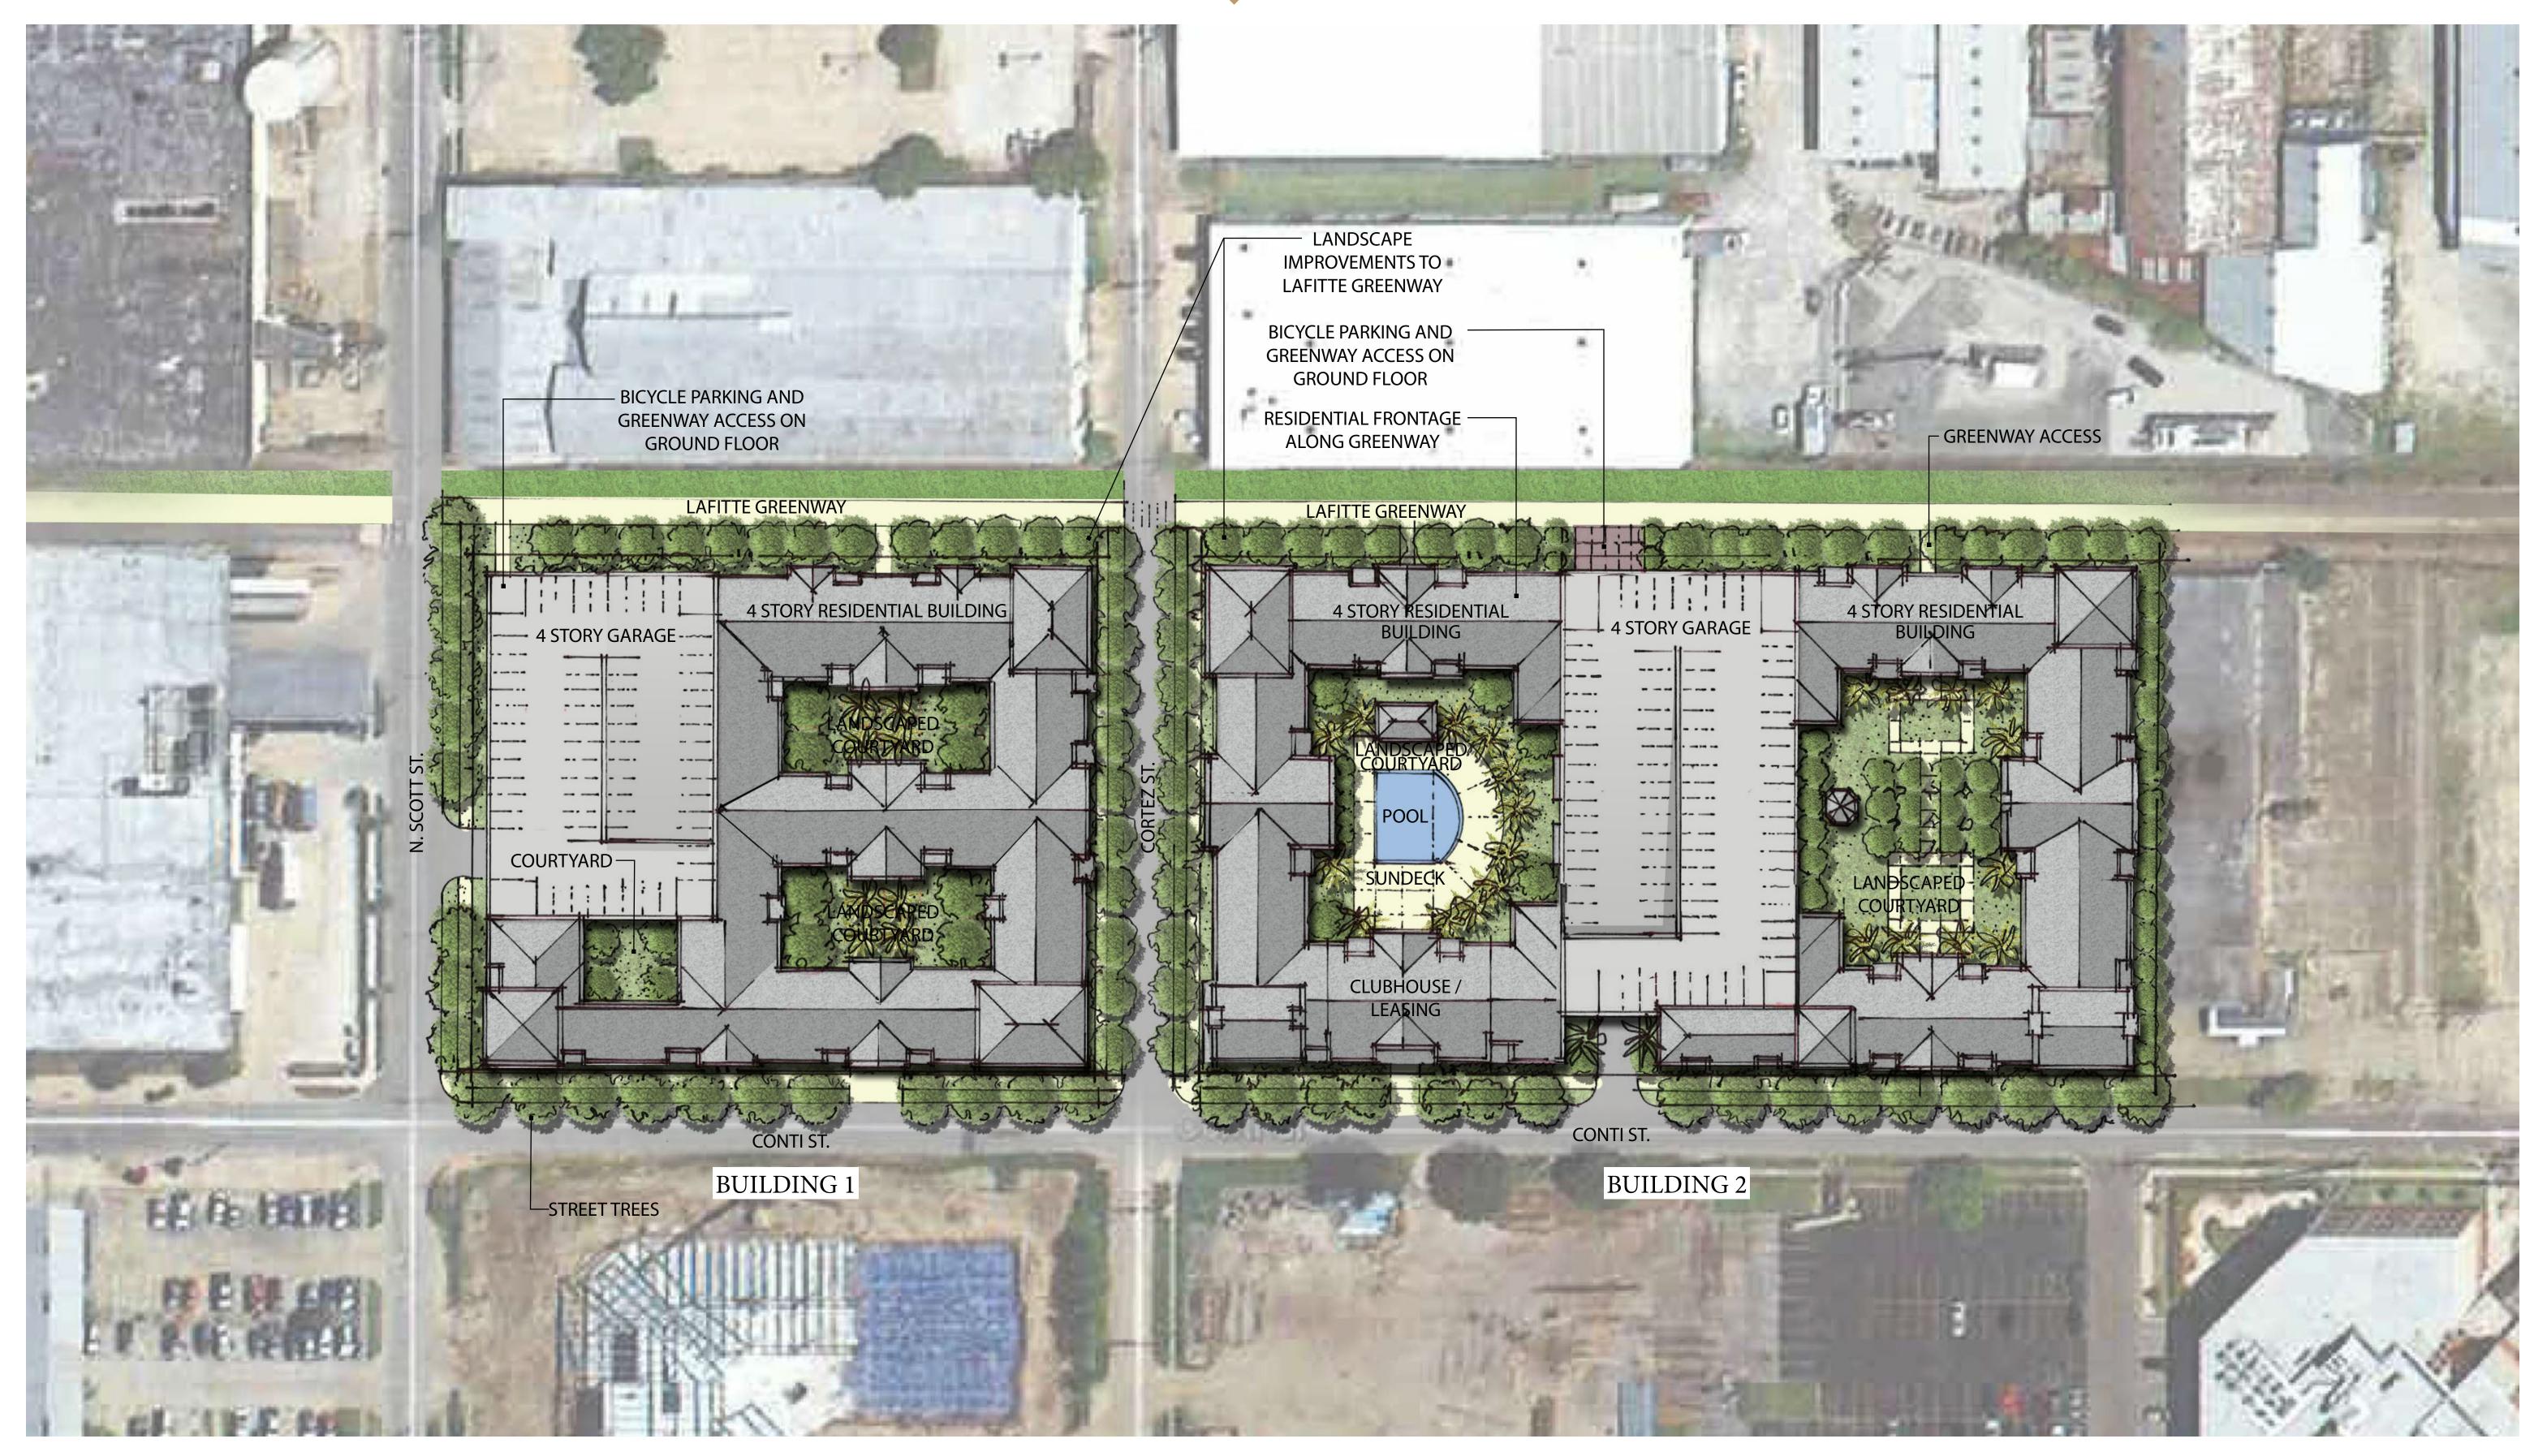

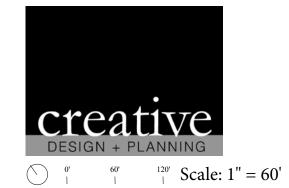











D LAFITTE GREENWAY ELEVATION

1/16"=1'-0"





N. CORTEZ STREET EAST ELEVATION

1/16"=1'-0"





A CONTI STREET ELEVATION
1/16"=1'-0"





D LAFITTE GREENWAY ELEVATION

1/16"=1'-0"





C EAST ELEVATION
1/16"=1'-0"

B N. CORTEZ STREET ELEVATION



A CONTI STREET ELEVATION
1/16"=1'-0"





 BUILDING 1

 Floor
 1st
 2nd
 3rd
 4th
 TOTAL
 %

 2BR
 10
 10
 10
 10
 40
 24.4%

 1BR/DEN
 0
 0
 0
 0
 0.0%

 1BR
 27
 27
 27
 27
 108
 65.9%


 STUDIO
 4
 4
 4
 4
 16
 9.7%

 TOTAL
 41
 41
 41
 41
 164


1.4 SPACES PER UNIT (164) = 230 SPACES

OVERALL								
Floor	1st	2nd	3rd	4th	TOTAL	%		
2BR	20	21	22	22	85	22.3%		
1BR/DEN	0	2	2	2	6	1.6%		
1BR	63	63	65	65	256	67.0%		
STUDIO	8	9	9	9	35	9.1%		
TOTAL	91	95	98	98	382			


BUILDING 2						
Floor	1st	2nd	3rd	4th	TOTAL	%
2BR	10	11	12	12	45	20.6%
1BR/DEN	0	2	2	2	6	2.8%
1BR	36	36	38	38	148	67.9%
STUDIO	4	5	5	5	19	8.7%
TOTAL	50	54	57	57	218	
PARKING 1.4 SPACES PER UNIT (218) = 305 SPACES						

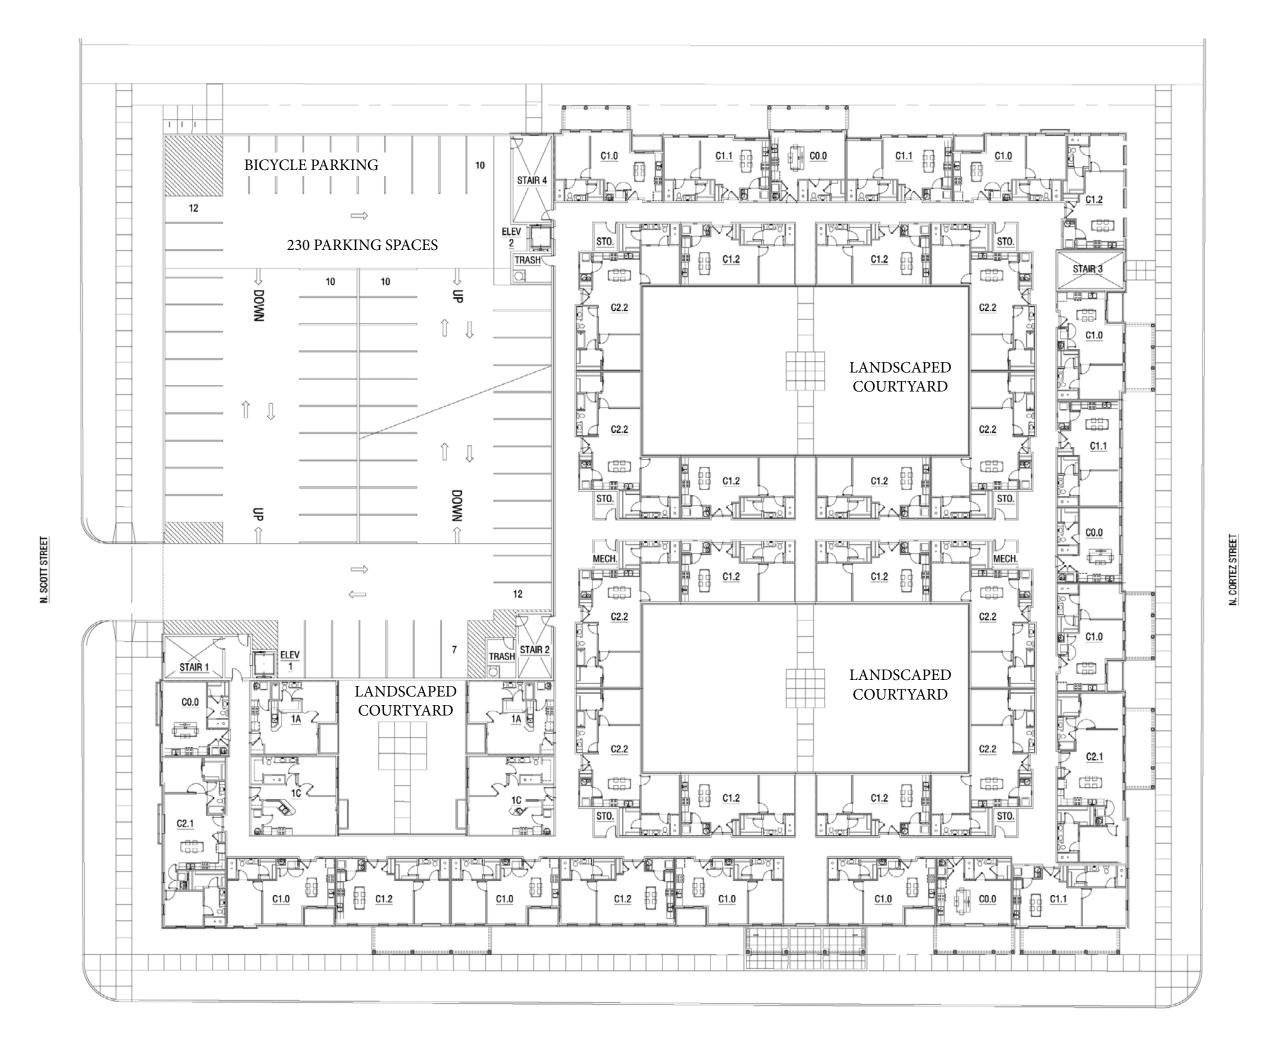

PARKING

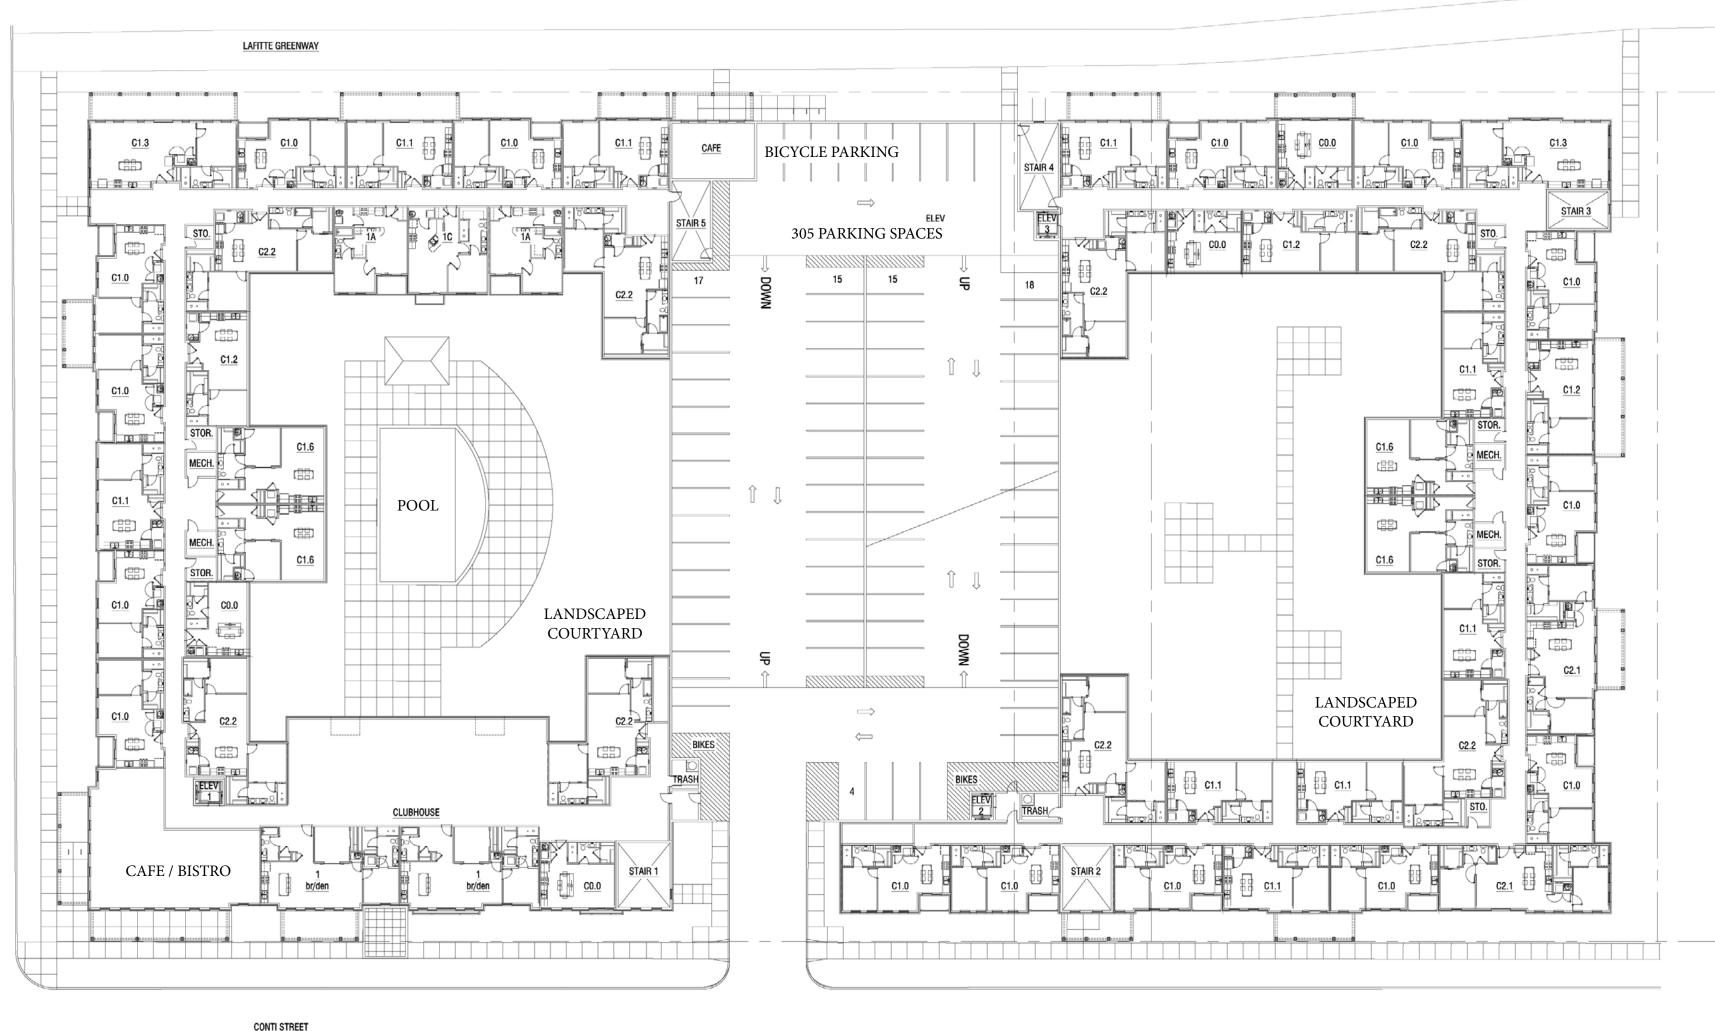

BUILDING 1
BUILDING 2

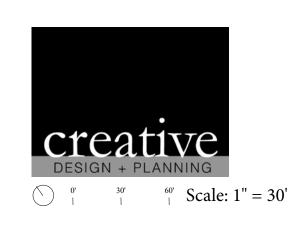



BUILDING 1


Floor	1st	2nd	3rd	4th	TOTAL	%
2BR	10	10	10	10	40	24.4%
1BR/DEN	0	0	0	0	0	0.0%
1BR	27	27	27	27	108	65.9%
STUDIO	4	4	4	4	16	9.7%
TOTAL	41	41	41	41	164	

OVERALL

0 12.0 (22							
Floor	1st	2nd	3rd	4th	TOTAL	%	
2BR	20	21	22	22	85	22.3%	
1BR/DEN	0	2	2	2	6	1.6%	
1BR	63	63	65	65	256	67.0%	
STUDIO	8	9	9	9	35	9.1%	
TOTAL	91	95	98	98	382		


BUILDING 2

Floor	1st	2nd	3rd	4th	TOTAL	%
2BR	10	11	12	12	45	20.6%
1BR/DEN	0	2	2	2	6	2.8%
1BR	36	36	38	38	148	67.9%
STUDIO	4	5	5	5	19	8.7%
TOTAL	50	54	57	57	218	

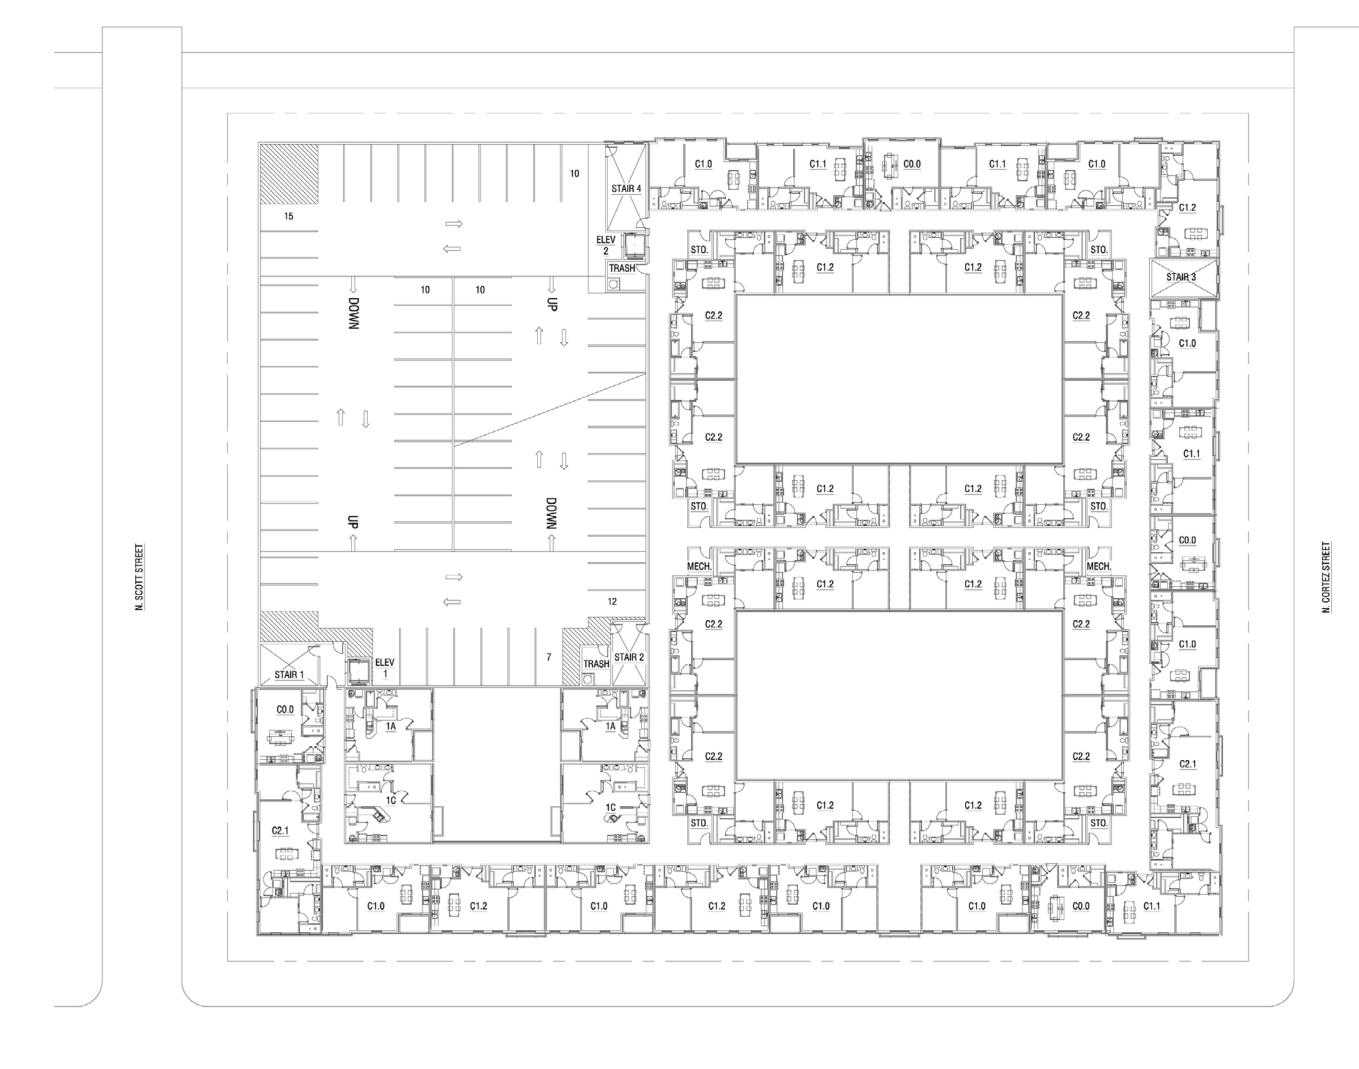

CONTI ST

BUILDING 1
BUILDING 2

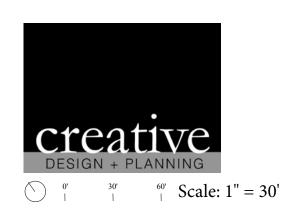




BUILDING 1


Floor	1st	2nd	3rd	4th	TOTAL	%
2BR	10	10	10	10	40	24.4%
1BR/DEN	0	0	0	0	0	0.0%
1BR	27	27	27	27	108	65.9%
STUDIO	4	4	4	4	16	9.7%
TOTAL	41	41	41	41	164	

OVERALL								
Floor	1st	2nd	3rd	4th	TOTAL	%		
2BR	20	21	22	22	85	22.3%		
1BR/DEN	0	2	2	2	6	1.6%		
1BR	63	63	65	65	256	67.0%		
STUDIO	8	9	9	9	35	9.1%		

91 95 98 98 382


BUILDING 2						
Floor	1st	2nd	3rd	4th	TOTAL	%
2BR	10	11	12	12	45	20.6%
1BR/DEN	0	2	2	2	6	2.8%
1BR	36	36	38	38	148	67.9%
STUDIO	4	5	5	5	19	8.7%
TOTAL	50	54	57	57	218	

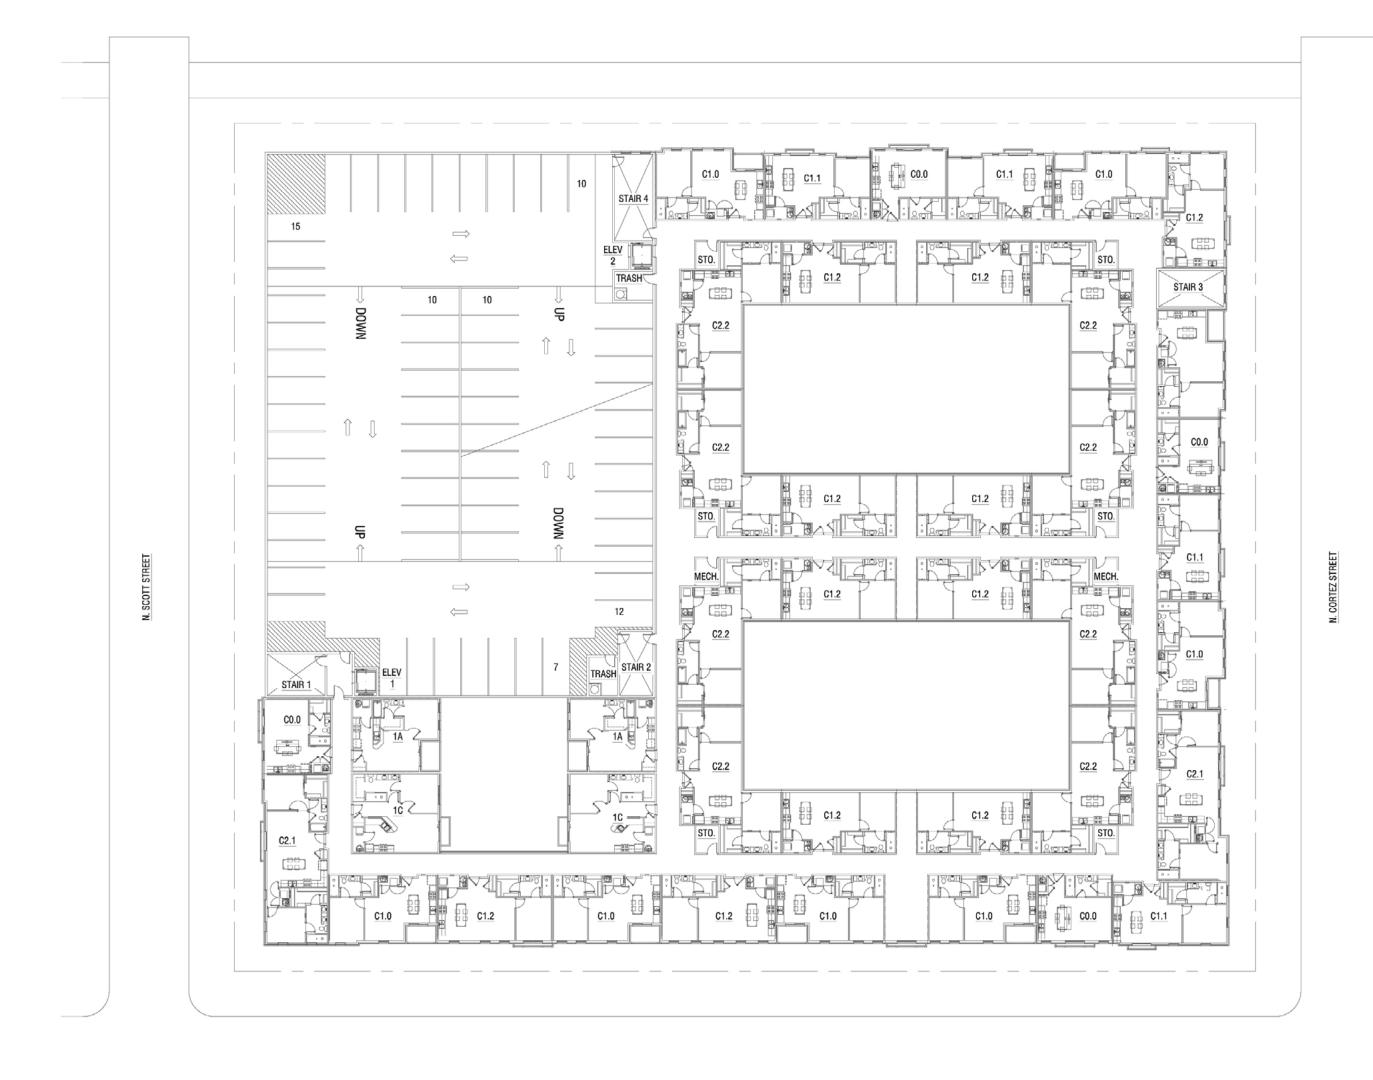


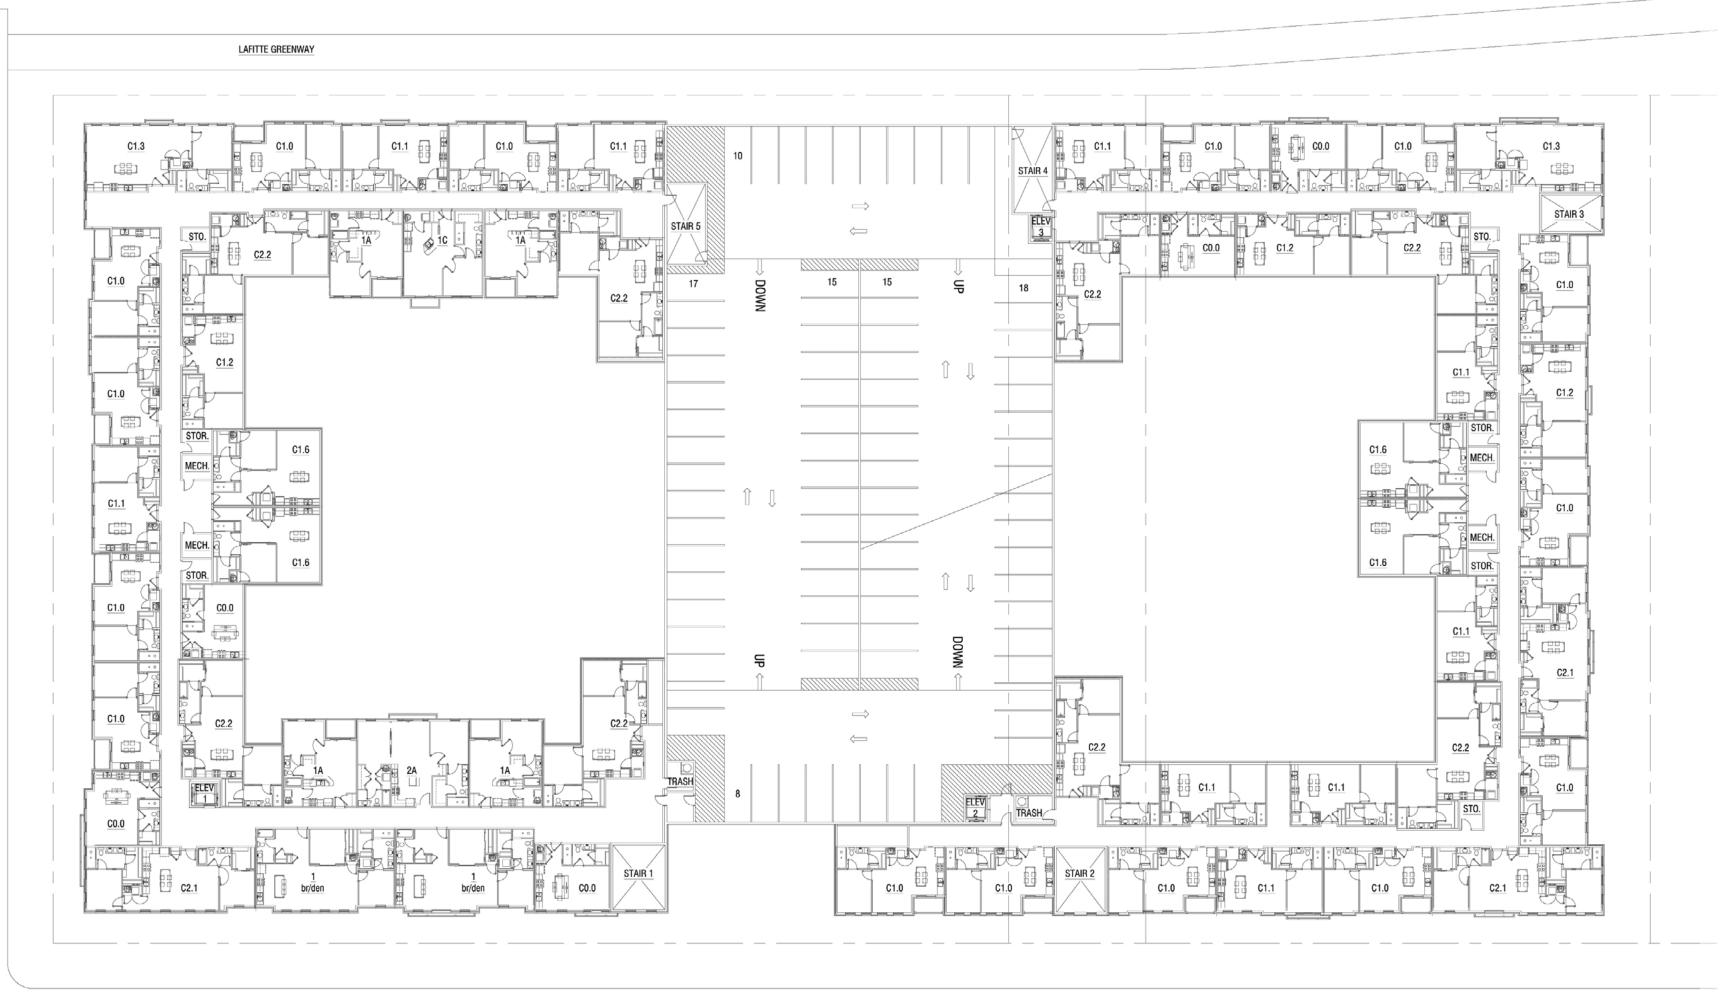


BUILDING 1

BUILDING 2

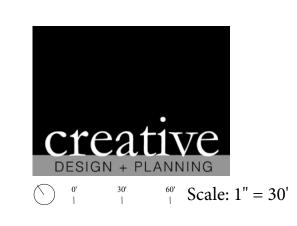

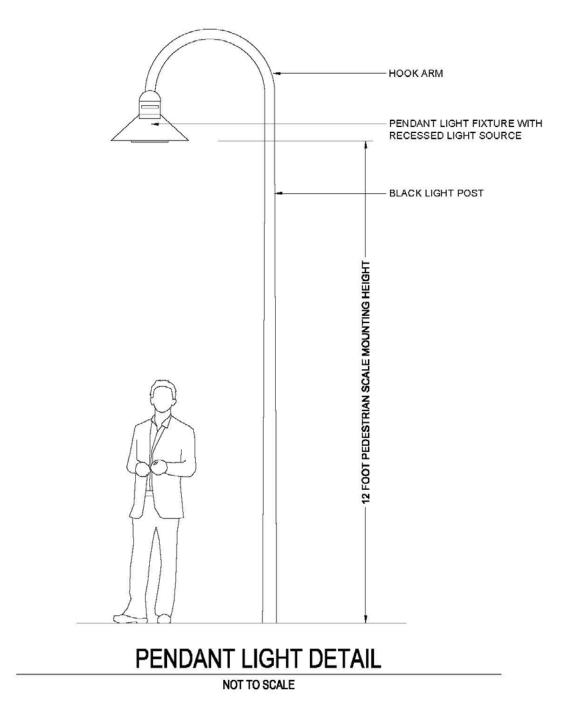

LIGHT FIXTURE INFORMATION US ARCHITECTURAL #XPK-1 DSAR1-III-64VLED-NW-120 277V-1-RAL9005T(BKM) LED FIXTURE

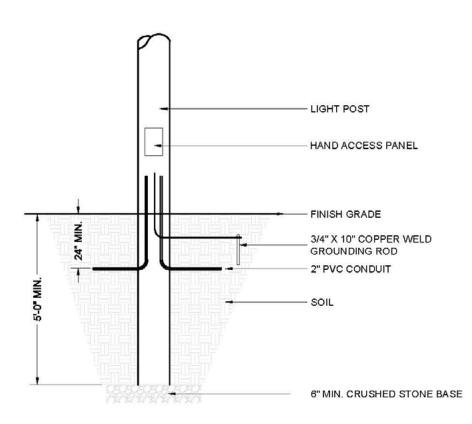

DIRECT BURY LIGHT POLE DETAIL NOT TO SCALE

STARBOARD MILK GLASS PENDANT RESTORATION HARDWARE BASIS OF DESIGN


- Forged from aluminum and brass
 Enclosure in milk glass
 Heavy-duty cage protects the bulb
 Adjustable pole ensures correct height
 Uses one 40W max. Type A equivalent bulb (included)
- Damp UL listed: suitable for use indoors, such as bathrooms where it is subject to moisture, and in sheltered outdoor areas Hardwire
- Dimensions • 8 11/16" diam., lamp 4 7/16 diam., 12"H

BALCONY LIGHT FIXTURE



EXTERIOR BUILDING FIXTURE




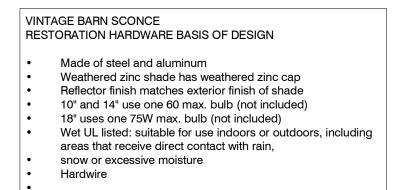



• 10" Sconce: 10" diam. x 141/4"D x 11"H






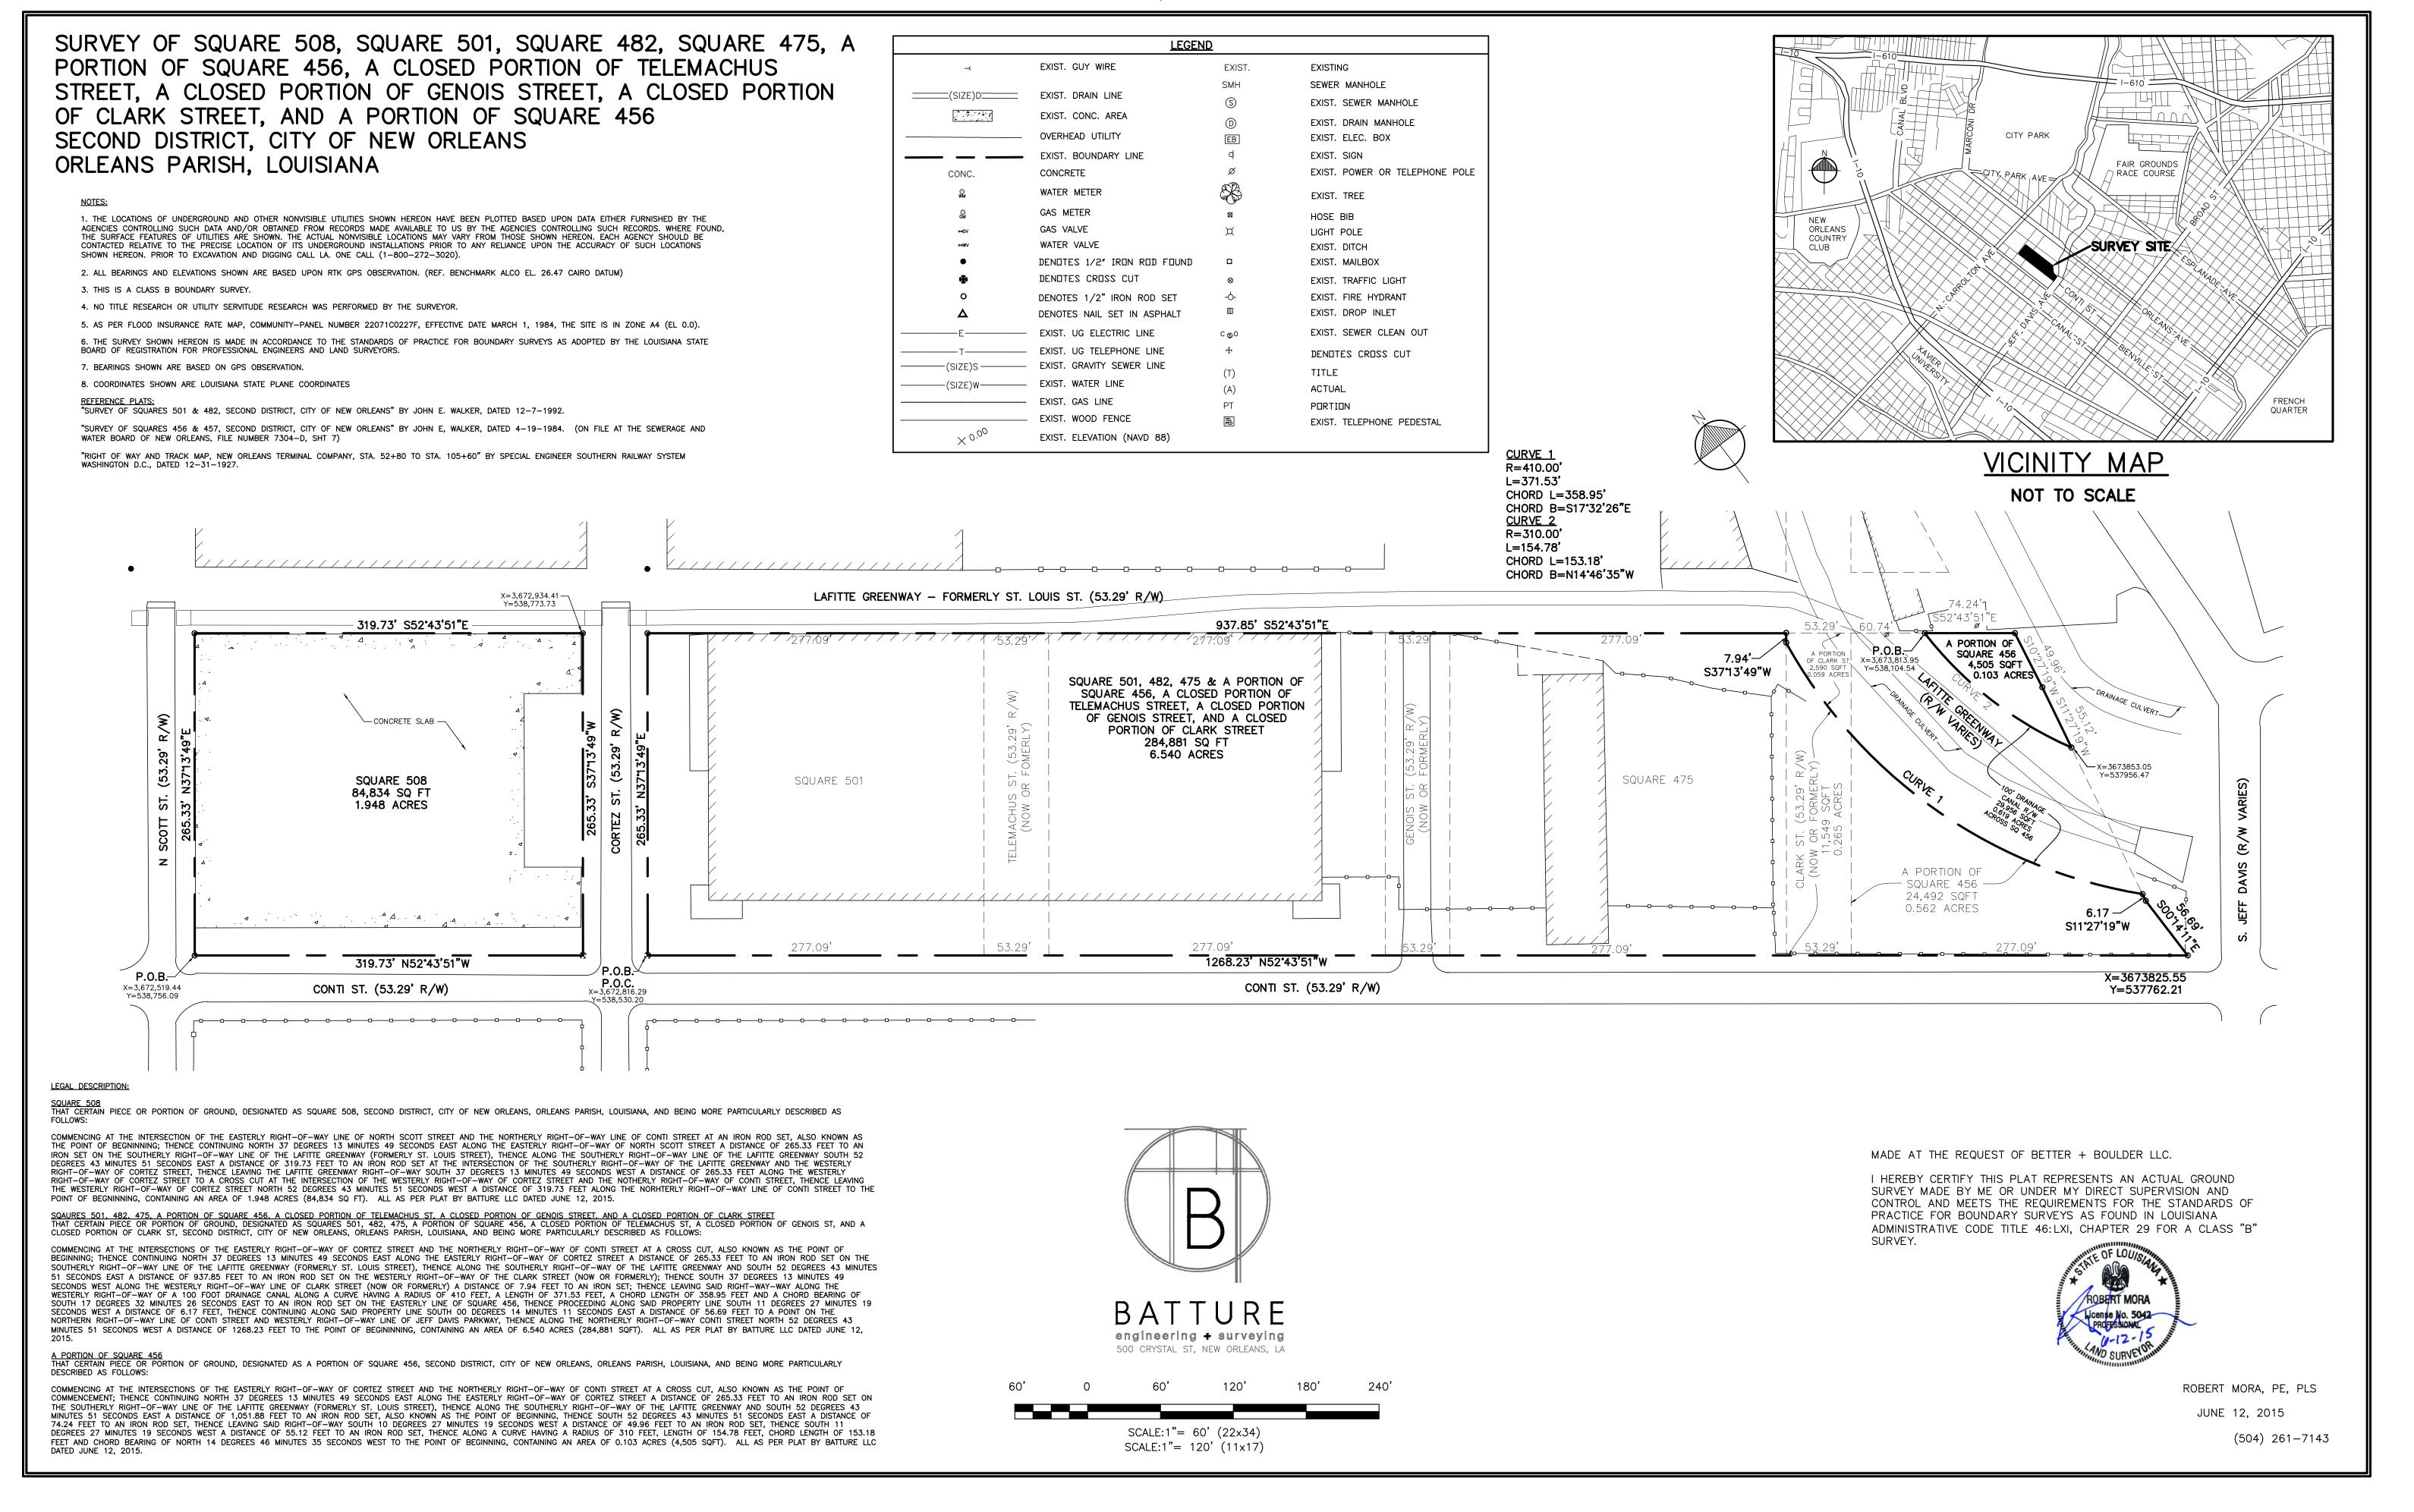

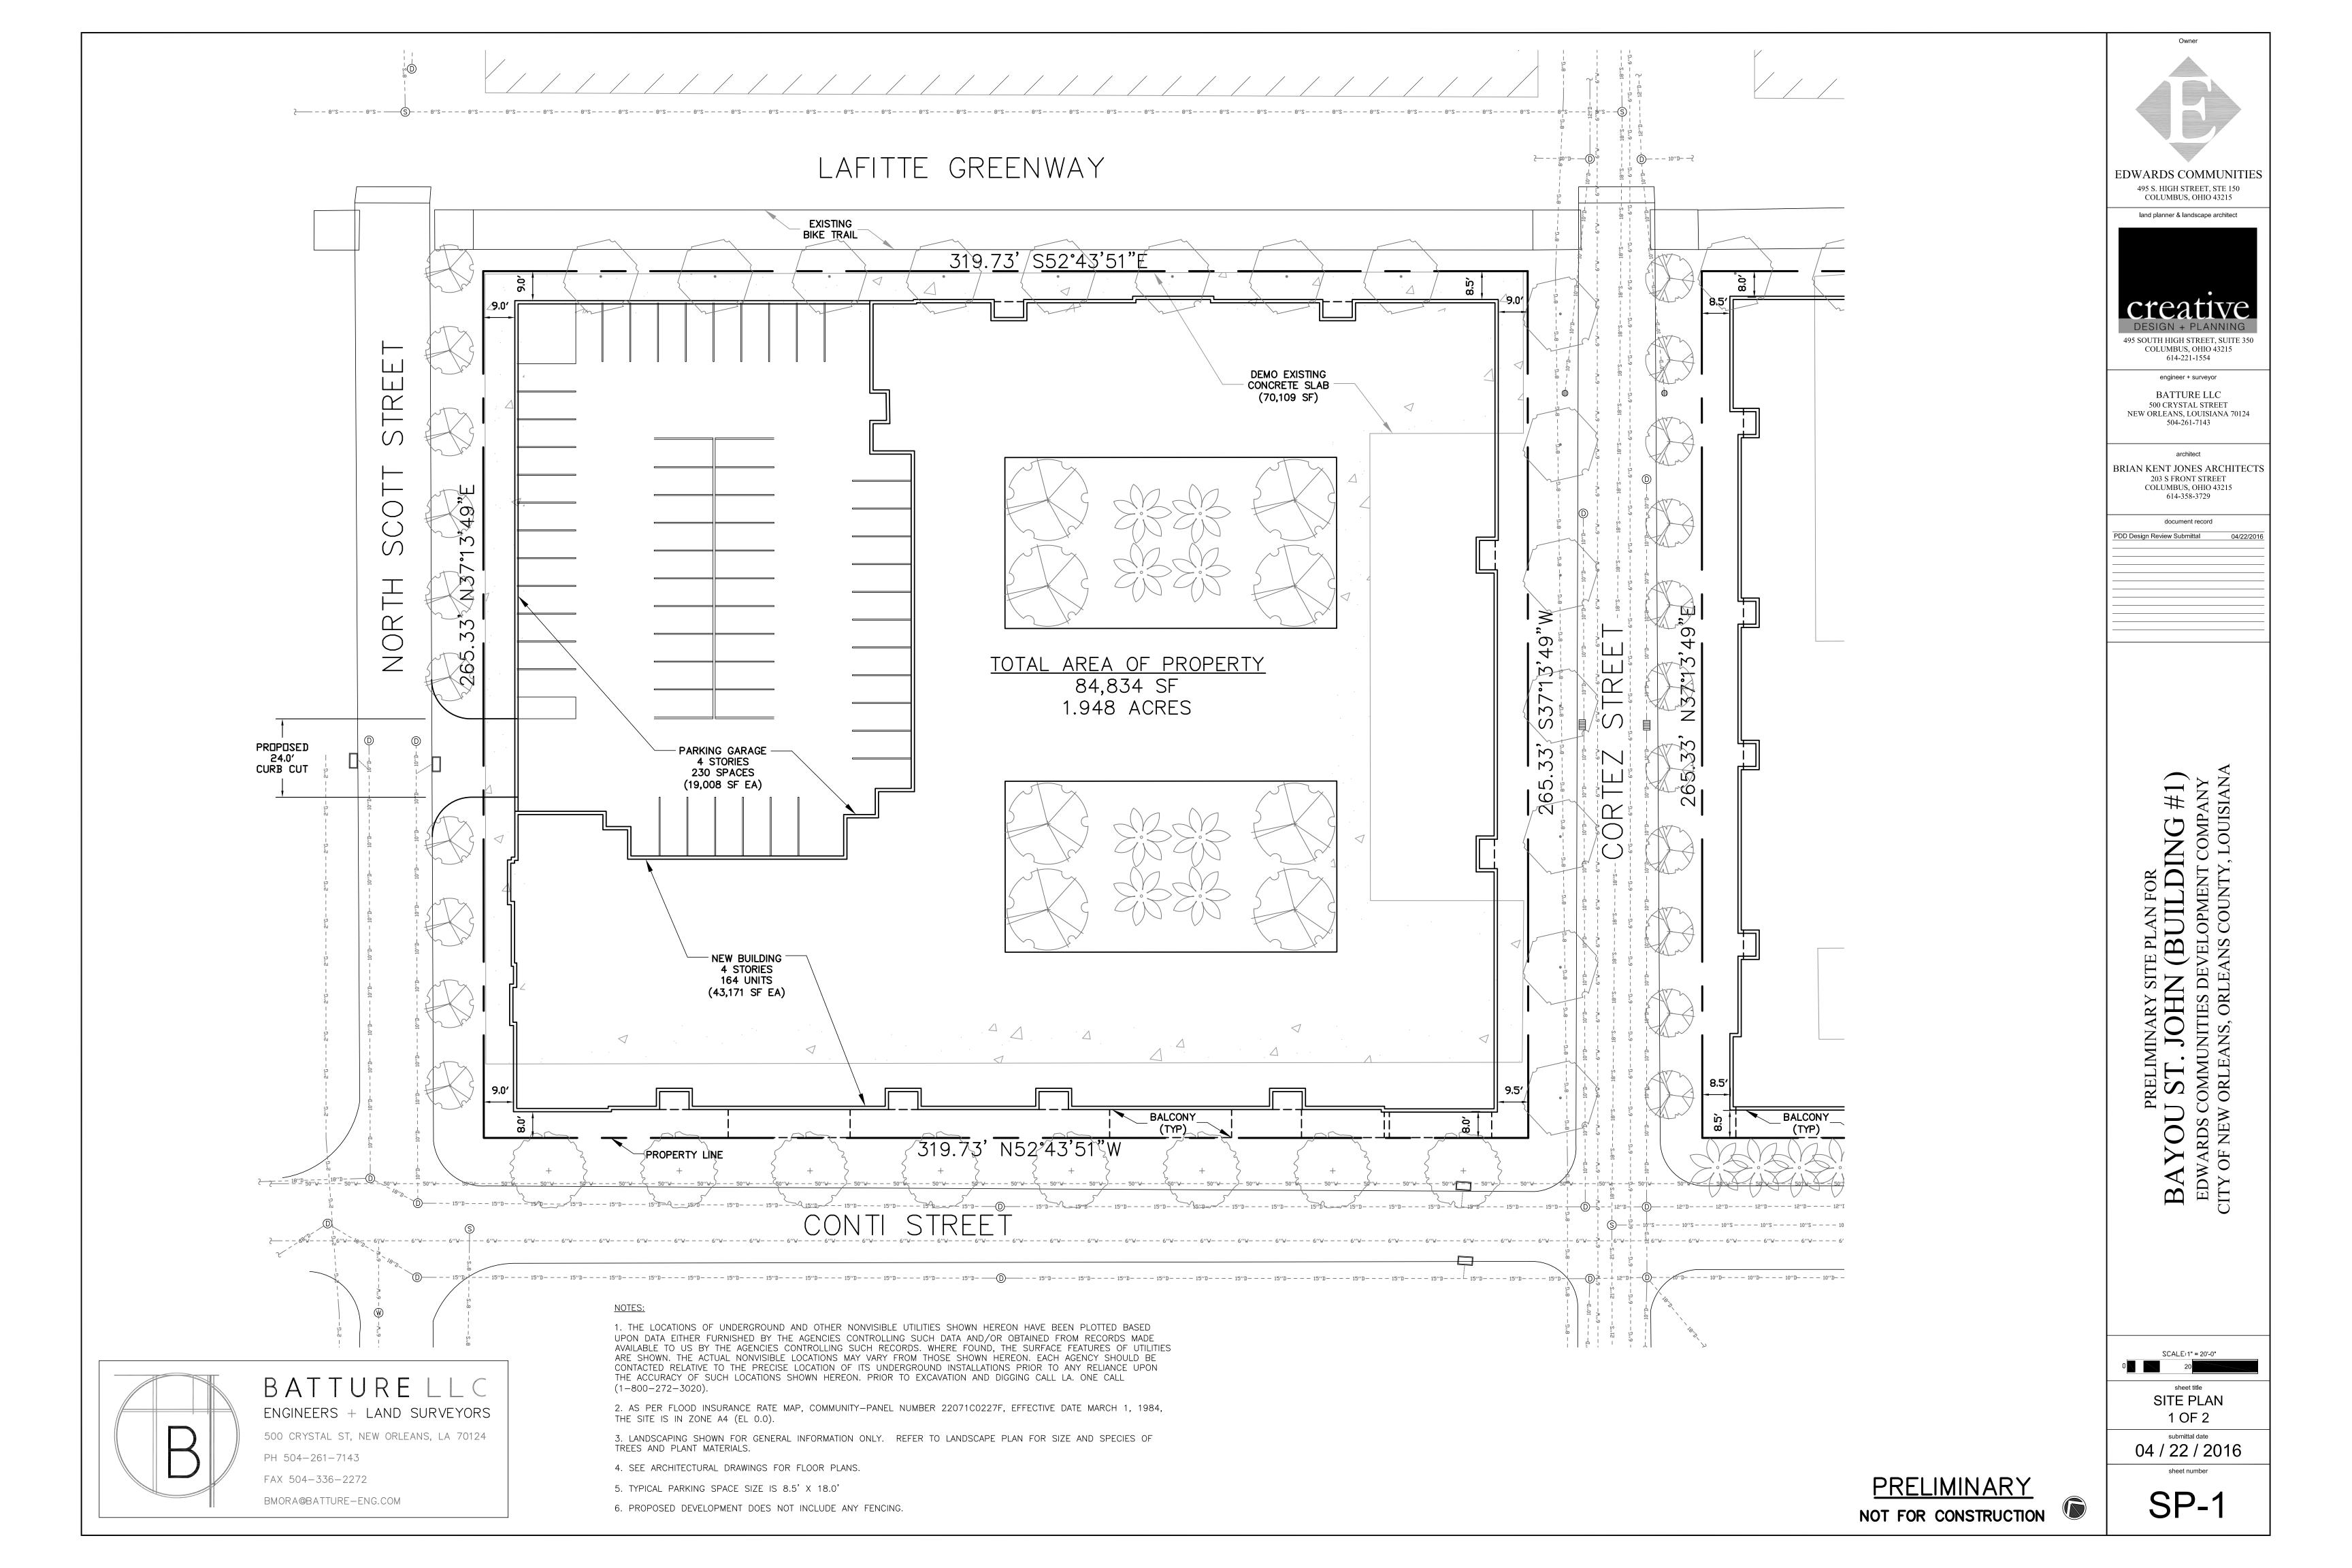

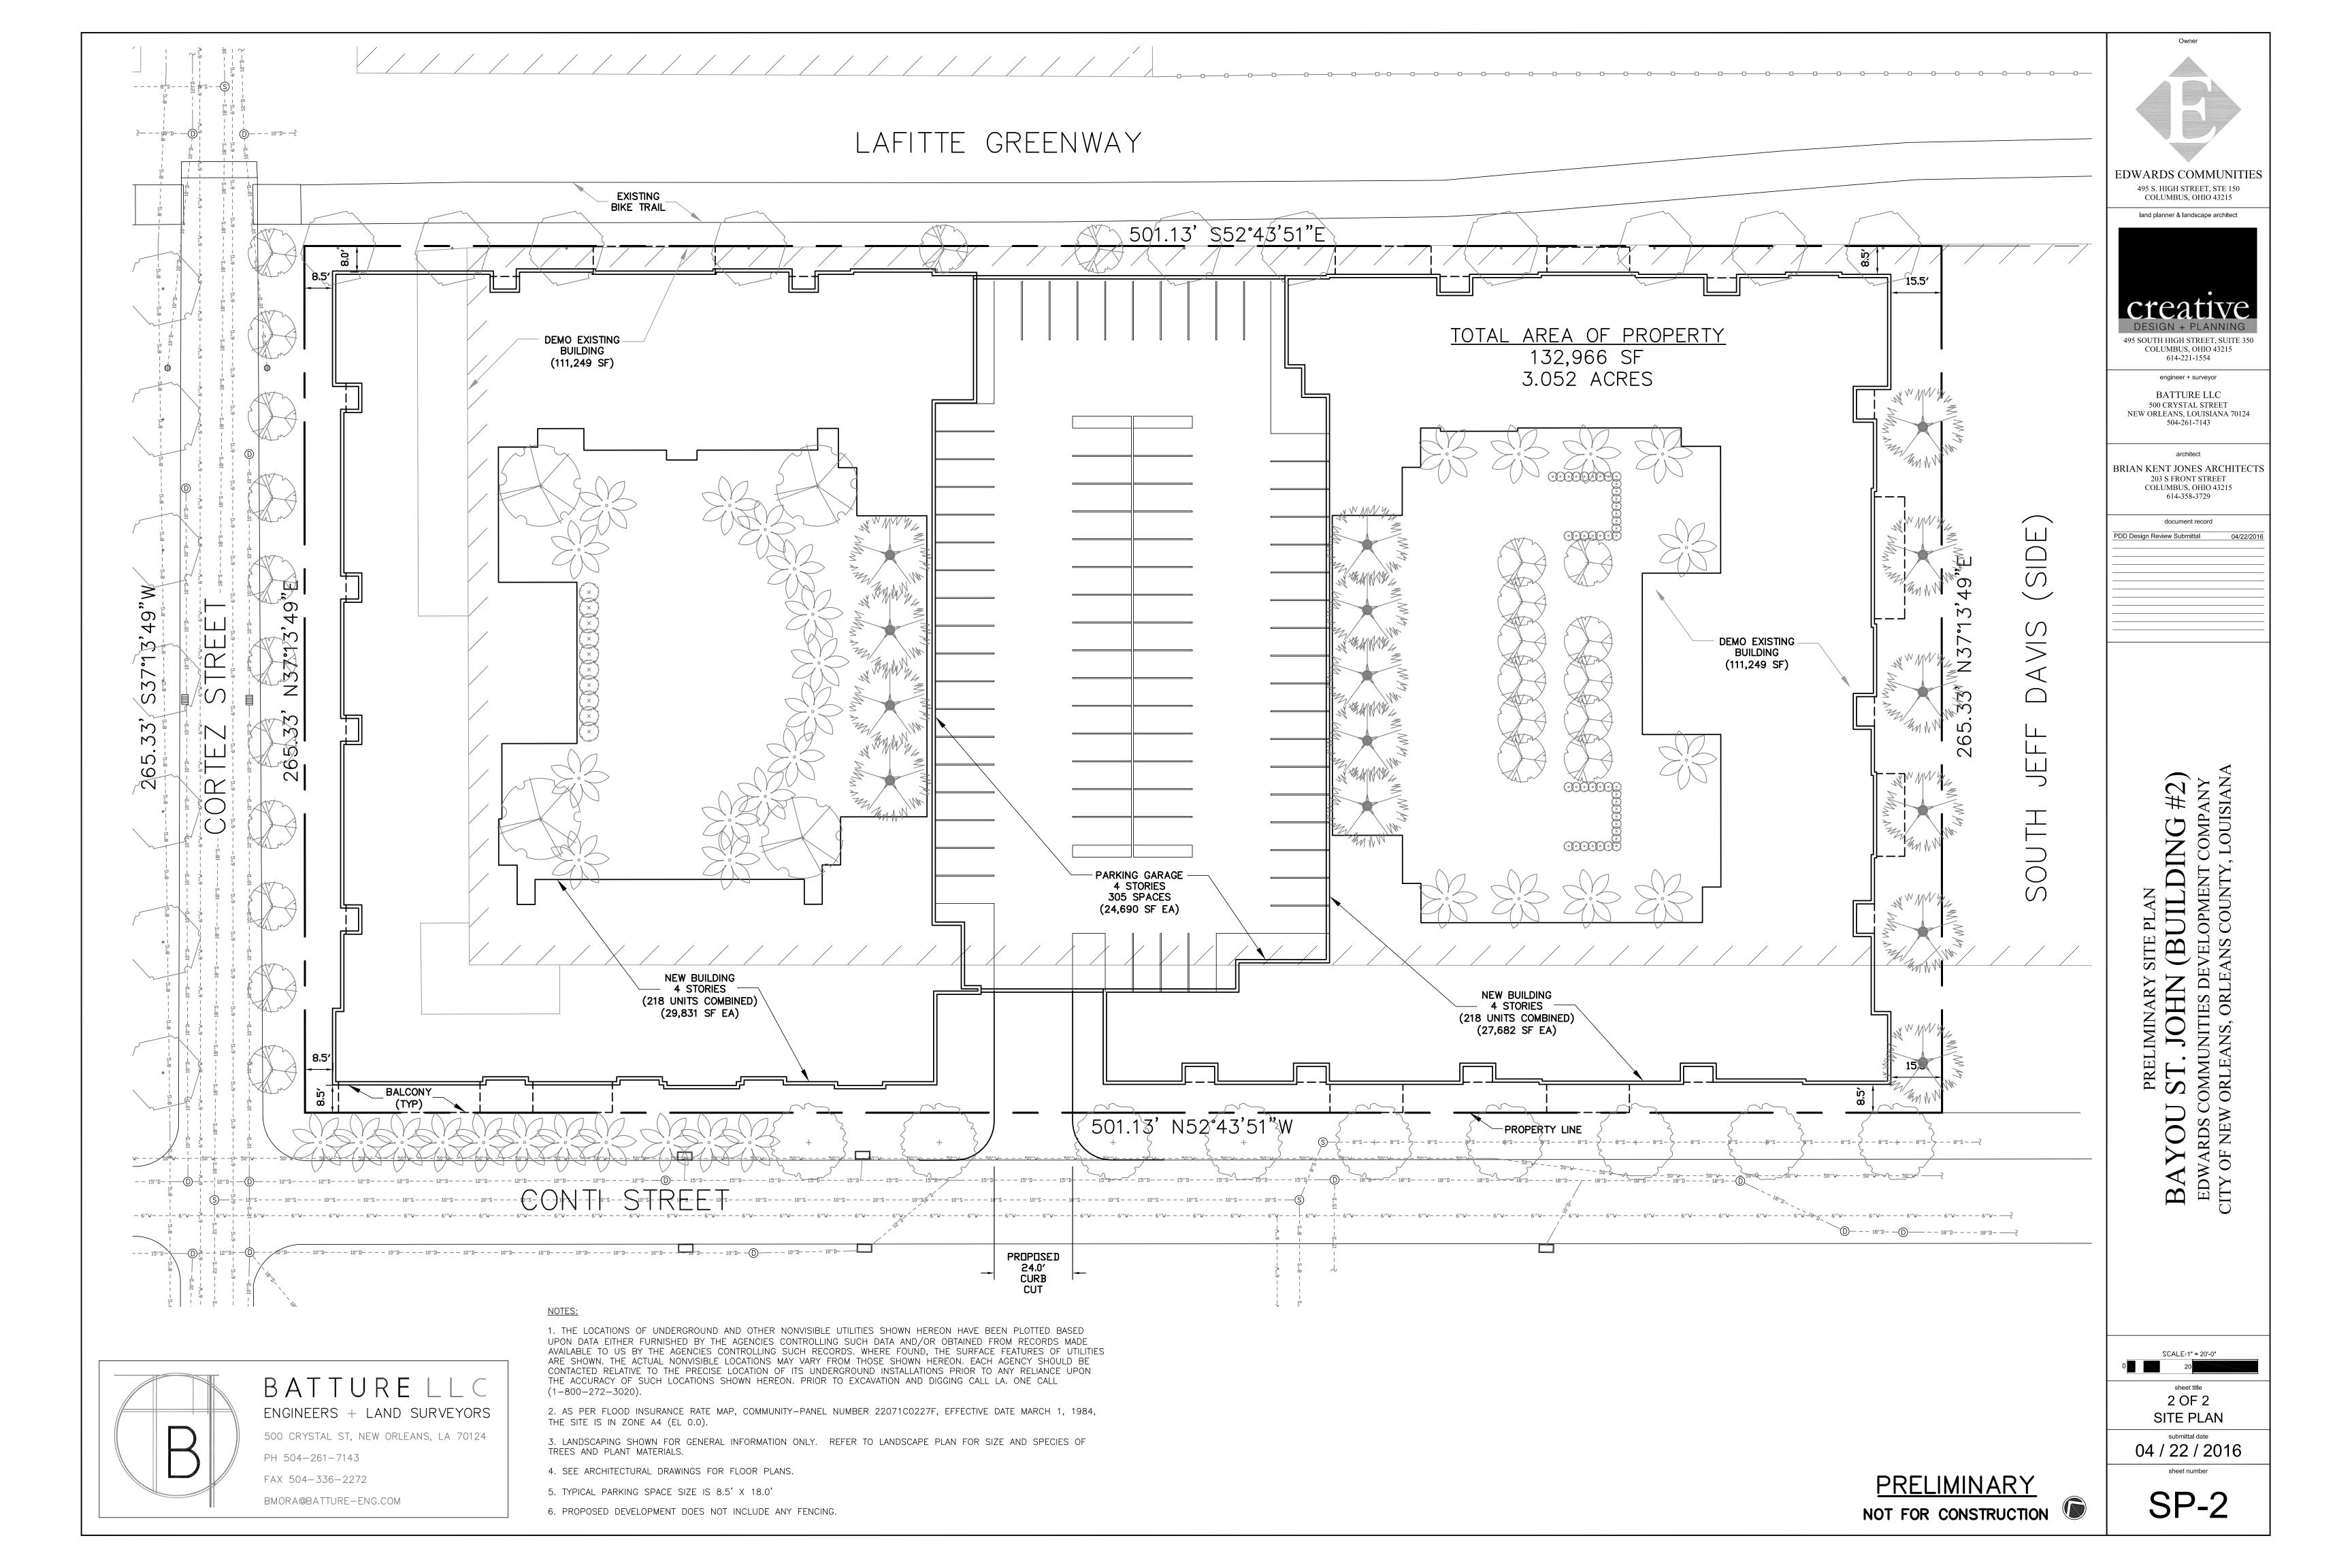


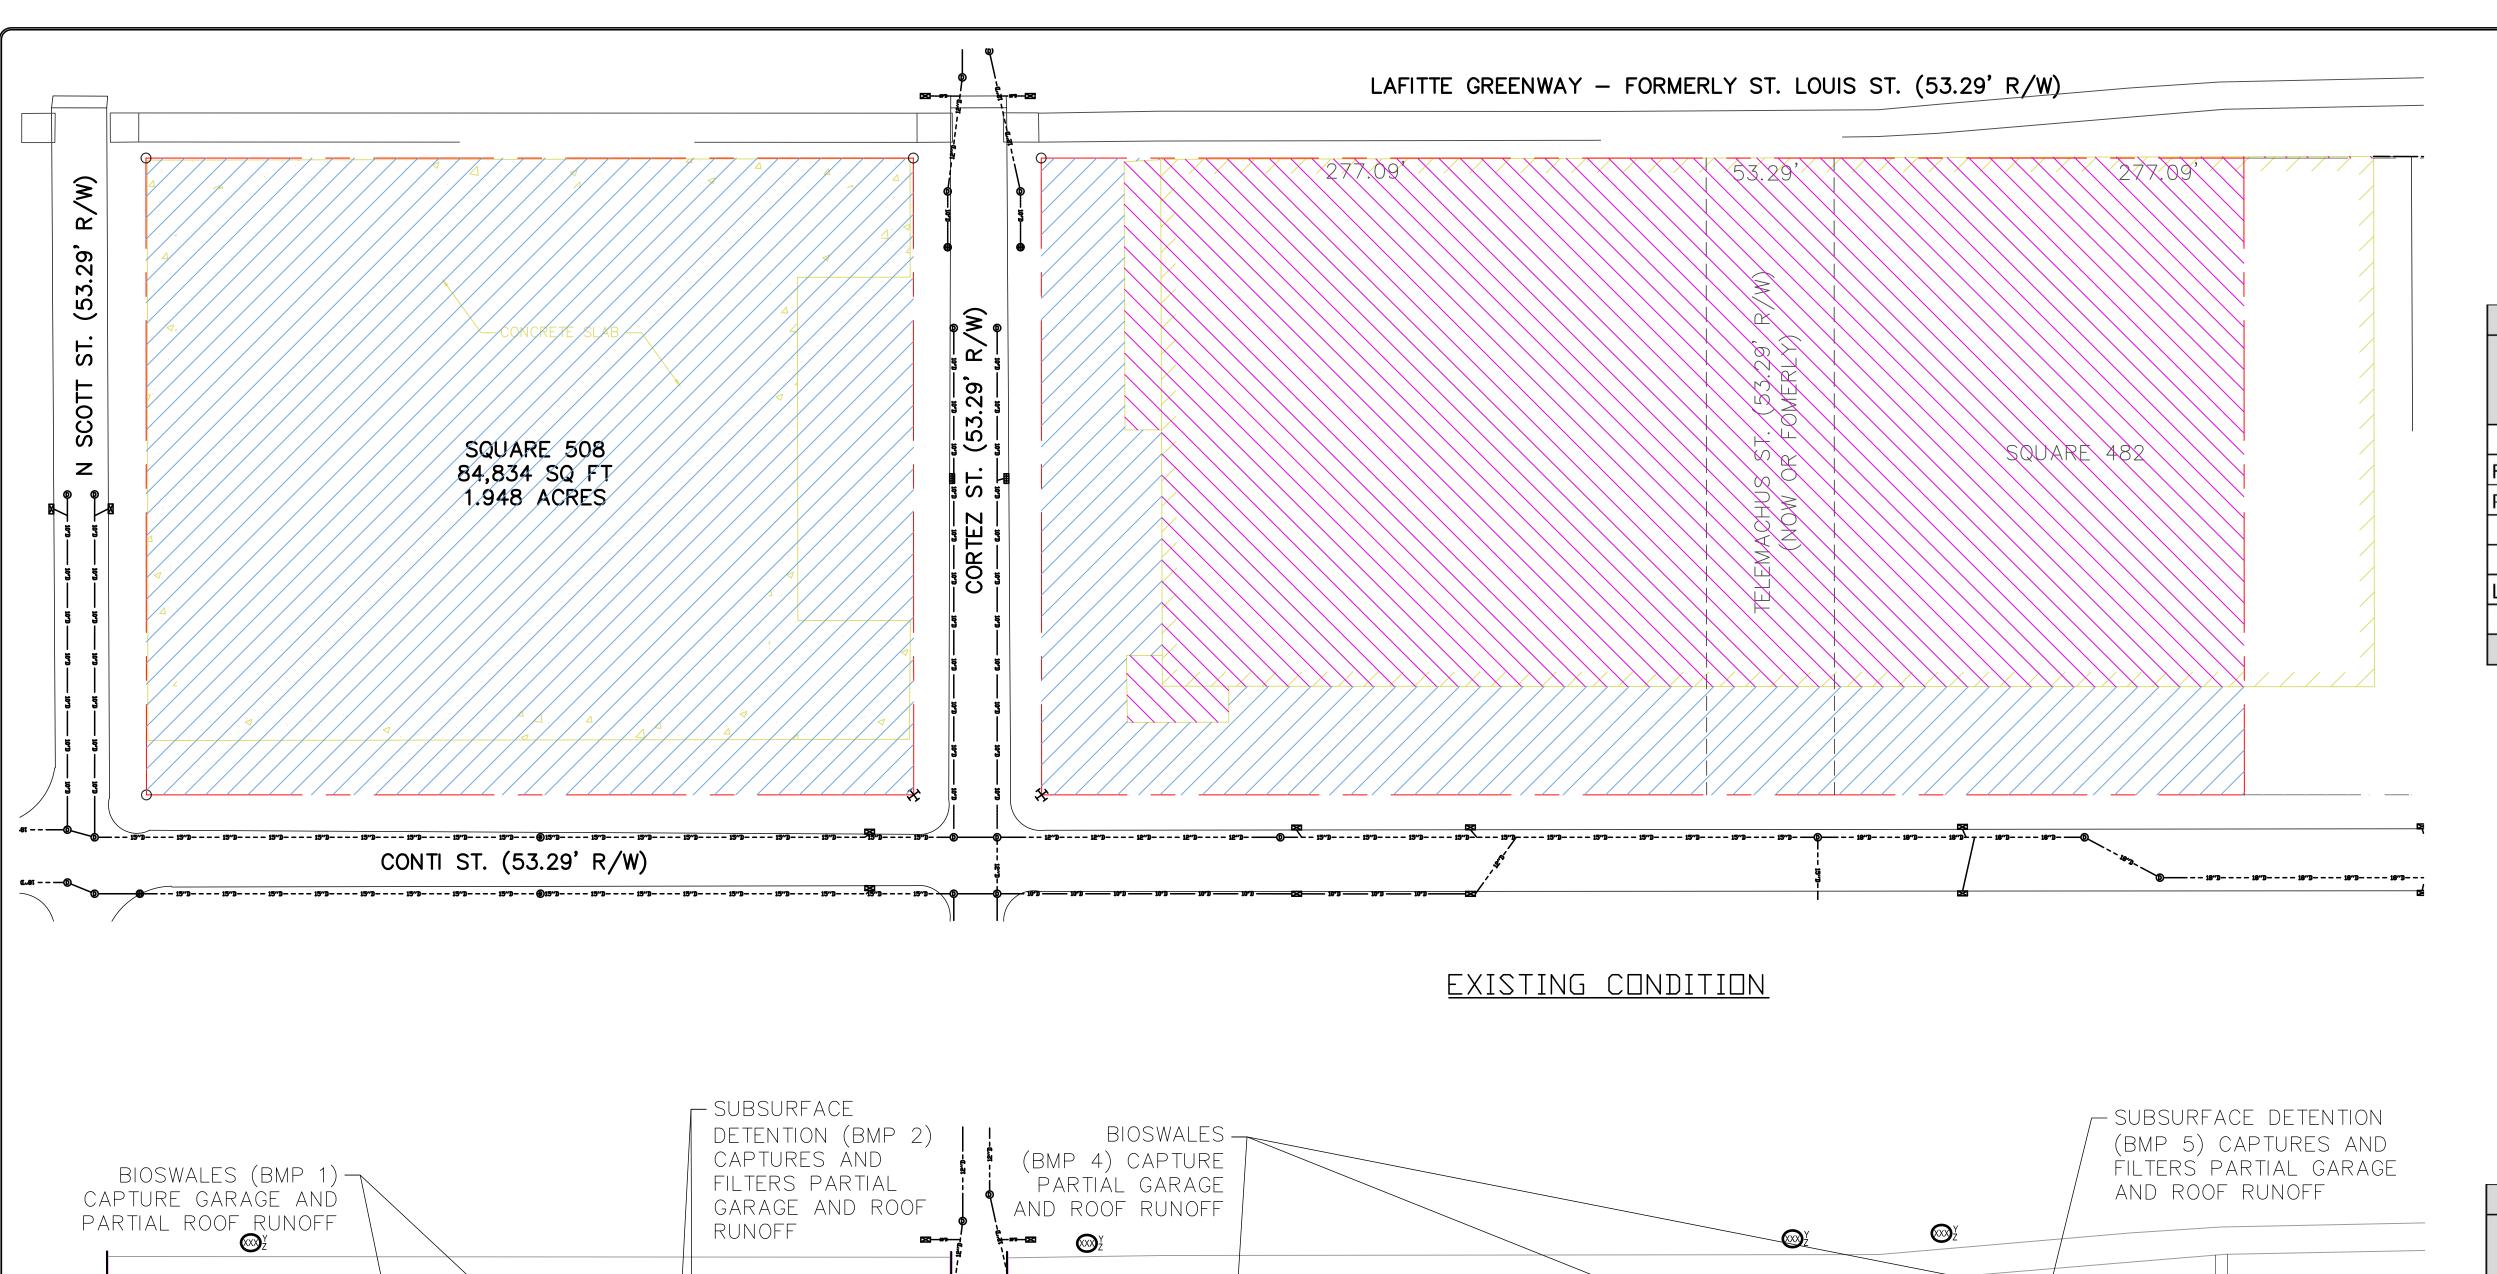

└ FLOW-THROUGH

ROOF RUNOFF

PLANTERS (BMP 3) CAPTURE PARTIAL

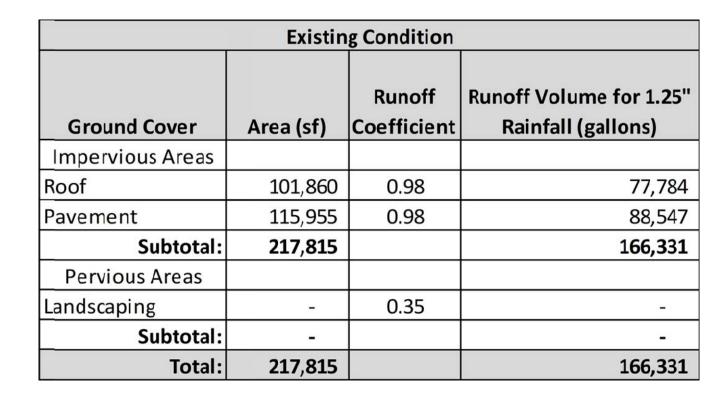

	Proposed Condition							
Ground Cover		Area (sf)	Runoff Coefficient	- 2	off Volume for 1.25" Rainfall (gallons)			
Impervious Areas Roof 10 Pavement 5								
		106,606	0.98		81,408			
		55,838	0.98		42,640			
		162,444			124,048			
La	ndscaping	55,371	0.35		15,101			
	Subtotal:	55,371			15,101			
	Total:	217,815			139,149			
Management Strategy					Runoff Treated (gallor			
J	Bioswales north o	of western bu	ıilding		19,3			
	Subsurface deten	tion in weste	rn courtyard	s	37,3			

	Management Strategy	Runoff Treated (gallons)
1	Bioswales north of western building	19,318
2	Subsurface detention in western courtyards	37,320
3	Flow-through planters in western courtyards	2,581
4	Bioswales north of eastern building	14,147
5	Subsurface detention in eastern courtyard	65,789
	Total:	139.155

XXYZ

PROPOSED CONDITION

	Total:	139,155
	N	
60 0 30	GRAPHIC SCALE (IN FEET) 1 inch = 60 ft.	240

GRAPHIC SCALE 50 0 30 60 120 240	ention in eastern courtyard	65,789
GRAPHIC SCALE 50 0 30 60 120 240	Total:	139,155
60 0 30 60 120 240	N	
1 inch = 60 ft.	60 0 30 60 (IN FEET)	120 240

UHU NHU BAY□U MENT COMMUNITY DRLEANS, RESIDENTIAL EDV

> PROJ. MGR.: __**JMS**__ DRAWN BY: KJG CHECKED BY: TLK

SCALE:

SHEET

4/22/2016

536 Washington Ave. New Orleans, LA 70130 o. 504.962.5360 f. 504.962.5362 www.gaeaconsultants.com



